



Bid Notice Abstract

Request for Quotation (RFQ)

Reference Number 10054375
Procuring Entity CARLOS HILADO MEMORIAL STATE UNIVERSITY
Title Procurement of Labor and Materials for the Construction of Fishpond Roofing at the Ground Floor ETG Building at Talisay Campus
Area of Delivery Negros Occidental

| | | | |
|--|---|------------------------------|---------------------|
| Solicitation Number: | RFQ 23-383 | Status | Pending |
| Trade Agreement: | Implementing Rules and Regulations | | |
| Procurement Mode: | Negotiated Procurement - Small Value Procurement (Sec. 53.9) | Associated Components | 1 |
| Classification: | Civil Works | Bid Supplements | 0 |
| Category: | Construction Projects | | |
| Approved Budget for the Contract: | PHP 130,000.00 | Document Request List | 0 |
| Delivery Period: | 15 Day/s | | |
| Client Agency: | | Date Published | 18/08/2023 |
| Contact Person: | Rowena De la Vida Prado Administrative Assistant II Mabini Street Talisay City Negros Occidental Philippines 6115 63-34-7120003 Ext.142 bac.sec@chmsu.edu.ph | Last Updated / Time | 17/08/2023 14:32 PM |
| | | Closing Date / Time | 21/08/2023 14:00 PM |

Description

Republic of the Philippines
 CARLOS HILADO MEMORIAL STATE UNIVERSITY
 Talisay City, Negros Occidental
 Telefax: (034) 712-8404 / 712-0003 Local 142
 bac.sec@chmsc.edu.ph

REQUEST FOR QUOTATION
 Page 1 of 4
 Date: AUGUST 17, 2023
 Quotation No. 23-383

Please quote your lowest price on the item/s listed below, stating the shortest time of delivery and submit your quotation duly signed by your representative not later than _____ in the return envelope attached herewith.

DR. ANDREW EUSEBIO S.TAN
 BAC Chairman

NOTE:

- ALL ENTRIES MUST BE TYPEWRITTEN
- DELIVERY PERIOD WITHIN 15 CALENDAR DAYS
- WARRANTY SHALL BE FOR A PERIOD OF SIX (6) MONTHS FOR SUPPLIES & MATERIALS, ONE (1) YEAR FOR EQUIPMENT, FROM DATE OF ACCEPTANCE BY THE PROCURING ENTITY

4. PRICE VALIDITY SHALL BE FOR A PERIOD OF _____ CALENDAR DAYS
5. G-EPS REGISTRATION CERTIFICATE SHALL BE ATTACHED UPON SUBMISSION OF THE QUOTATION
6. BIDDERS SHALL SUBMIT ORIGINAL BROCHURES SHOWING CERTIFICATIONS OF THE PRODUCT BEING OFFERED

ITEM DESCRIPTION OF WORKS QTY. UNIT MATERIAL COST LABOR COST TOTAL COST

NO. Unit Cost Material Sub-Total Cost Unit Cost Labor Sub-Total Cost

ONE (1) LOT

LABOR AND MATERIALS FOR THE CONSTRUCTION OF FISHPOND ROOFING AT GROUND FLOOR ETG BUILDING AT TALISAY CAMPUS

Scope of Works:

1.0 GENERAL REQUIREMENTS

- 1.1 Mobilization and Demobilization
- 1.2 Safety Occupational Hazards
- 1.3 Site Clearing, Cleaning and Hauling

2.0 ARCHITECTURAL WORKS

2.1 ROOF FRAMING WORKS

- 2.1.1 Fabrication and Installation of Roof Framing
- 2.1.2 Installation of Polycarbonate Sheet
- 2.1.3 Installation of Roofing Accessories

2.2 MASONRY AND PAINTING WORKS

- 2.2.1 Surface Preparation and Painting of Roof Framing
- 2.2.2 Plastering and Finishing of Damage Concrete Walls and Installation of Stone Cladding
- 2.2.3 Surface Preparation and Painting of Damage Concrete Walls
- 2.2.4 Water Proofing of Pre-cast large garden urns (Including Surface preparation and Surface painting)
- 2.2.5 Cleaning of fish Pond
- 2.2.6 Repainting of Existing walls under the installed fish pond roofing
- 2.2.7 Lanscaping Design and accent for the fish pond plant platform

2.3 PLUMBING WORKS

- 2.3.1 Rehabilitation of Fish pond Plumbing system and Water Feature
- 2.3.2 Installation of Pre-cast large garden Urns and Water feature

BILL OF QUANTITIES

1.0 GENERAL REQUIREMENTS

- 1.1 Mobilization and Demobilization 1 lot
- 1.2 Safety Occupational Hazards 1 lot
- 1.3 Site Clearing,Cleaning and Hauling 1 lot

Sub-total, 1.0 (GENERAL REQUIREMENTS)

2.0 ARCHITECTURAL WORKS

ROOF FRAMING WORKS

Fabrication and Installation of Roof Framing, Polycarbonate Sheet

- 2.1.1 1.2m x 1.2m Mini-Rib Polycarbonate Sheet "Brown" 14 lnm
- 2.1.2 1.2mm x 2" x 2" Steel Tubular 8 lghts
- 2.1.3 1/8" x 1" Flat Bar 3 lghts
- 2.1.4 1 1/2" Teckscrew Full thread 100 pcs
- 2.1.5 Silicone Sealant 2 tube
- 2.1.6 Diamond Cutting Disc 4" 1 pcs
- 2.1.7 Welding Rod 6011 5 kls
- 2.1.8 Pre-painted G.I. Sheet 4' x 8' x 0.4mm 2 shts
- 2.1.9 Fabrication & Installation of 12 sets Steel Plate for Steel Rafter Attachment with 4" Expansion Bolts 1 lot

2.2 MASONRY AND PAINTING WORKS

- 2.1.10 Surface Preparation and Painting of Roof Framing 1 lot
- 2.1.11 Plastering and Finishing of Damage Concrete Walls and Existing Wall 1 lot
- 2.1.12 Surface Preparation and Painting of Damage Concrete Walls 1 lot
- 2.1.13 Installation of Stone Cladding 1 lot
- 2.1.14 Repainting of Existing walls under the installed fish pond roofing 1 lot
- 2.1.15 Lanscaping Design and accent for the fish pond plant platform 1 lot

2.3 PLUMBING WORKS

- 2.1.16 Rehabilitation of Fish pond Plumbing system and Water Feature 1 lot
- 2.1.17 Installation of Pre-cast large garden Urns and Water feature 1 lot

Sub-total, 2.1 (MASONRY, ROOF FRAMING AND PAINTING WORKS)

3.0 MISCELLANEOUS WORKS

FOR ALL OTHER ITEMS that are not included on listed Bill of Quantities in your Bid but tare deemed necessary for the completion of the works and the delivery of the project and in full compliance with all the requirements of the occupancy permit. 1.00 lot

Sub-total, 3.0 (MISCELLANEOUS WORKS)

PROJECT DURATION: 15 CALENDAR DAYS

Note: Attach Certificate of Site Inspection

A. TOTAL DIRECT COST

B. CONSUMABLES:

C. SUPERVISION AND ADMINISTRATION:

D. TOTAL INDIRECT COST (B+C):

E. TOTAL COST (A+D)
 F. VAT (12% OF ITEM E):
 GRAND TOTAL OF PROJECT COST:
 *****NOTHING FOLLOWS*****
 TOTAL ABC = Php 130,000.00
 PROCUREMENT OF LABOR AND MATERIALS FOR THE CONSTRUCTION OF FISHPOND ROOFING AT GROUND FLOOR
 ETG BUILDING AT TALISAY CAMPUS - J. MARQUEZ
 PR# 23-440-0816 08-16-23
 INCOME 288-164-23-08 08-16-23

Line Items

| Item No. | Product/Service Name | Description | Quantity | UOM | Budget (PHP) |
|----------|----------------------|---|----------|-----|--------------|
| 1 | ONE (1) LOT | Labor and Materials for the Construction of Fishpond Roofing at the Ground Floor ETG Building at Talisay Campus | 1 | Lot | 130,000.00 |

Created by Rowena De la Vida Prado

Date Created 17/08/2023

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DR. ANDREW EUSEBIO S. TAN
 BAC Chairman

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3. WARRANTY SHALL BE FOR A PERIOD OF SIX (6) MONTHS FOR SUPPLIES & MATERIALS, ONE (1) YEAR FOR EQUIPMENT, FROM DATE OF ACCEPTANCE BY THE PROCURING ENTITY
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5. G-EPS REGISTRATION CERTIFICATE SHALL BE ATTACHED UPON SUBMISSION OF THE QUOTATION
6. BIDDERS SHALL SUBMIT ORIGINAL BROCHURES SHOWING CERTIFICATIONS OF THE PRODUCT BEING OFFERED

| ITEM NO. | DESCRIPTION OF WORKS | QTY. | UNIT | MATERIAL COST | | LABOR COST | | TOTAL COST |
|--|---|------|------|---------------|-------------------------|------------|----------------------|------------|
| | | | | Unit Cost | Material Sub-Total Cost | Unit Cost | Labor Sub-Total Cost | |
| ONE (1) LOT | | | | | | | | |
| LABOR AND MATERIALS FOR THE CONSTRUCTION OF FISHPOND ROOFING AT GROUND FLOOR ETG BUILDING AT TALISAY CAMPUS | | | | | | | | |
| Scope of Works: | | | | | | | | |
| 1.0 | GENERAL REQUIREMENTS | | | | | | | |
| 1.1 | Mobilization and Demobilization | | | | | | | |
| 1.2 | Safety Occupational Hazards | | | | | | | |
| 1.3 | Site Clearing, Cleaning and Hauling | | | | | | | |
| 2.0 | ARCHITECTURAL WORKS | | | | | | | |
| 2.1 | ROOF FRAMING WORKS | | | | | | | |
| 2.1.1 | Fabrication and Installation of Roof Framing | | | | | | | |
| 2.1.2 | Installation of Polycarbonate Sheet | | | | | | | |
| 2.1.3 | Installation of Roofing Accessories | | | | | | | |
| 2.2 | MASONRY AND PAINTING WORKS | | | | | | | |
| 2.2.1 | Surface Preparation and Painting of Roof Framing | | | | | | | |
| 2.2.2 | Plastering and Finishing of Damage Concrete Walls and Installation of Stone Cladding | | | | | | | |
| 2.2.3 | Surface Preparation and Painting of Damage Concrete Walls | | | | | | | |
| 2.2.4 | Water Proofing of Pre-cast large garden urns (Including Surface preparation and Surface painting) | | | | | | | |
| 2.2.5 | Cleaning of fish Pond | | | | | | | |
| 2.2.6 | Repainting of Existing walls under the installed fish pond roofing | | | | | | | |
| 2.2.7 | Lanscaping Design and accent for the fish pond plant platform | | | | | | | |
| 2.3 | PLUMBING WORKS | | | | | | | |

Date _____ By _____
 Released (BAC) _____
 Returned (Supplier) _____

Printed Name/Signature _____
 Tel. No./Cellphone No. _____
 Date _____



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
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|---------------------------|---|------|-------|---------------|-------------------------|------------|----------------------|------------|
| | | | | Unit Cost | Material Sub-Total Cost | Unit Cost | Labor Sub-Total Cost | |
| 2.3.1 | Rehabilitation of Fish pond Plumbing system and Water Feature | | | | | | | |
| 2.3.2 | Installation of Pre-cast large garden Urns and Water feature | | | | | | | |
| BILL OF QUANTITIES | | | | | | | | |
| 1.0 | GENERAL REQUIREMENTS | | | | | | | |
| 1.1 | Mobilization and Demobilization | 1 | lot | | | | | |
| 1.2 | Safety Occupational Hazards | 1 | lot | | | | | |
| 1.3 | Site Clearing, Cleaning and Hauling | 1 | lot | | | | | |
| | Sub-total, 1.0 (GENERAL REQUIREMENTS) | | | | | | | |
| 2.0 | ARCHITECTURAL WORKS | | | | | | | |
| | ROOF FRAMING WORKS | | | | | | | |
| | Fabrication and Installation of Roof Framing, Polycarbonate Sheet | | | | | | | |
| 2.1.1 | 1.2m x 1.2m Mini-Rib Polycarbonate Sheet "Brown" | 14 | lnm | | | | | |
| 2.1.2 | 1.2mm x 2" x 2" Steel Tubular | 8 | lghts | | | | | |
| 2.1.3 | 1/8" x 1" Flat Bar | 3 | lghts | | | | | |
| 2.1.4 | 1 1/2" Teckscrew Full thread | 100 | pcs | | | | | |
| 2.1.5 | Silicone Sealant | 2 | tube | | | | | |
| 2.1.6 | Diamond Cutting Disc 4" | 1 | pcs | | | | | |
| 2.1.7 | Welding Rod 6011 | 5 | kls | | | | | |
| 2.1.8 | Pre-painted G.I. Sheet 4' x 8' x 0.4mm | 2 | shts | | | | | |
| 2.1.9 | Fabrication & Installation of 12 sets Steel Plate for Steel Rafter Attachment with 4" Expansion Bolts | 1 | lot | | | | | |

Date _____ By _____
 Released (BAC) _____
 Returned (Supplier) _____

Printed Name/Signature _____
 Tel. No /Cellphone No. _____
 Date _____



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| 2.2 | MASONRY AND PAINTING WORKS | | | | | | | |
| 2.1.10 | Surface Preparation and Painting of Roof Framing | 1 | lot | | | | | |
| 2.1.11 | Plastering and Finishing of Damage Concrete Walls and Existing Wall | 1 | lot | | | | | |
| 2.1.12 | Surface Preparation and Painting of Damage Concrete Walls | 1 | lot | | | | | |
| 2.1.13 | Installation of Stone Cladding | 1 | lot | | | | | |
| 2.1.14 | Repainting of Existing walls under the installed fish pond roofing | 1 | lot | | | | | |
| 2.1.15 | Lanscaping Design and accent for the fish pond plant platform | 1 | lot | | | | | |
| 2.3 | PLUMBING WORKS | | | | | | | |
| 2.1.16 | Rehabilitation of Fish pond Plumbing system and Water Feature | 1 | lot | | | | | |
| 2.1.17 | Installation of Pre-cast large garden Urns and Water feature | 1 | lot | | | | | |
| | Sub-total, 2.1 (MASONRY, ROOF FRAMING AND PAINTING WORKS) | | | | | | | |
| 3.0 | MISCELLANEOUS WORKS | | | | | | | |
| | FOR ALL OTHER ITEMS that are not included on listed Bill of Quantities in your Bid but are deemed necessary for the completion of the works and the delivery of the project and in full compliance with all the requirements of the occupancy permit. | 1.00 | lot | | | | | |
| | Sub-total, 3.0 (MISCELLANEOUS WORKS) | | | | | | | |
| | PROJECT DURATION: 15 CALENDAR DAYS | | | | | | | |
| | Note: Attach Certificate of Site Inspection | | | | | | | |

Released (BAC) _____ Date _____ By _____
 Returned (Supplier) _____

Printed Name/Signature _____

Tel. No./Cellphone No. _____

Date _____



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 BAC Chairman


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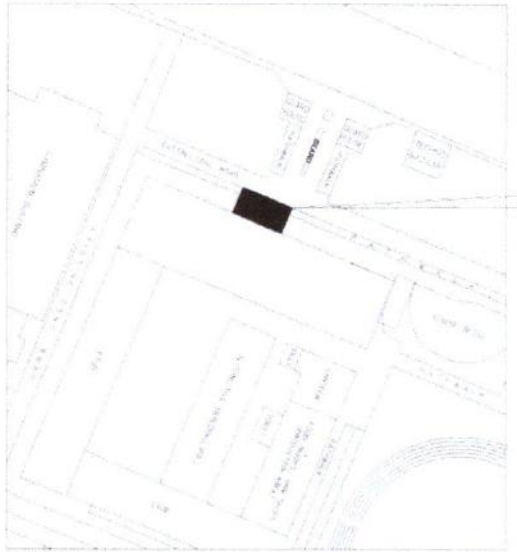
| ITEM NO. | DESCRIPTION OF WORKS | QTY. | UNIT | MATERIAL COST | | LABOR COST | | TOTAL COST |
|----------|---|----------------------|-----------------|---------------|-------------------------|------------|----------------------|------------|
| | | | | Unit Cost | Material Sub-Total Cost | Unit Cost | Labor Sub-Total Cost | |
| | A. TOTAL DIRECT COST | | | | | | | |
| | B. CONSUMABLES: | | | | | | | |
| | C. SUPERVISION AND ADMINISTRATION: | | | | | | | |
| | D. TOTAL INDIRECT COST (B+C): | | | | | | | |
| | E. TOTAL COST (A+D) | | | | | | | |
| | F. VAT (12% OF ITEM E): | | | | | | | |
| | GRAND TOTAL OF PROJECT COST: | | | | | | | |
| | *****NOTHING FOLLOWS***** | | | | | | | |
| | TOTAL ABC = Php 130,000.00 | | | | | | | |
| | PROCUREMENT OF LABOR AND MATERIALS FOR THE CONSTRUCTION OF FISHPOND ROOFING AT GROUND FLOOR ETG BUILDING AT TALISAY CAMPUS - J. MARQUEZ | | | | | | | |
| | PR# | 23-440-0816 | 08-16-23 | | | | | |
| | INCOME | 288-164-23-07 | 08-16-23 | | | | | |
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| | | | | | | | | |

Released (BAC) _____ Date _____ By _____
 Returned (Supplier) _____

Printed Name/Signature _____
 Tel. No./Cellphone No. _____
 Date _____



VICINITY MAP
SCALE NDTs

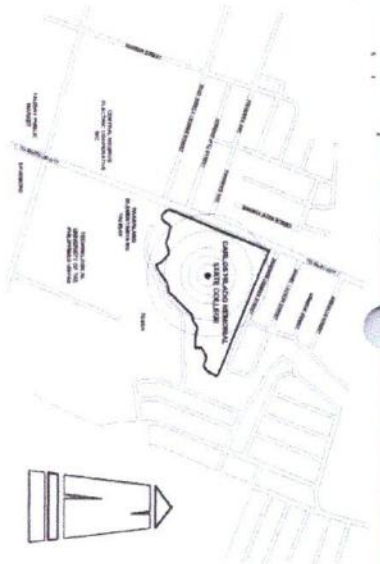

THE SITE



PERSPECTIVE DRAWING
SCALE NDTs

SITE DEVELOPMENT MAP
SCALE NDTs



Republic of the Philippines
DEPARTMENT OF EDUCATION
Office of Technical Education
CALICA BRANCO MEMORIAL
STATE UNIVERSITY
Naga City, Occidental
Mindanao

PROJECT TITLE:
CONSTRUCTION OF REPAIR AND ROOFING
AT GROUND FLOOR ETC BUILDING

PREPARED BY:
ARNEI R. LATIPINAS
UNIVERSITY DRAFTSMAN

CHECKED BY:
ENGR. CAROL A. TORONDO JR.
REGISTERED PROFESSIONAL ENGINEER


ENGR. JUN-JUN J. MENDOZA
DIRECTOR FROM

ROSALINDA S. BAYILLA, JD
VICE PRESIDENT FOR ADMINISTRATION AND FINANCE

ROBERTO P. MANGULABAN, PH.D
SIC PRESIDENT III

SHEET NO. 1
PAGE NO. 1

7/2

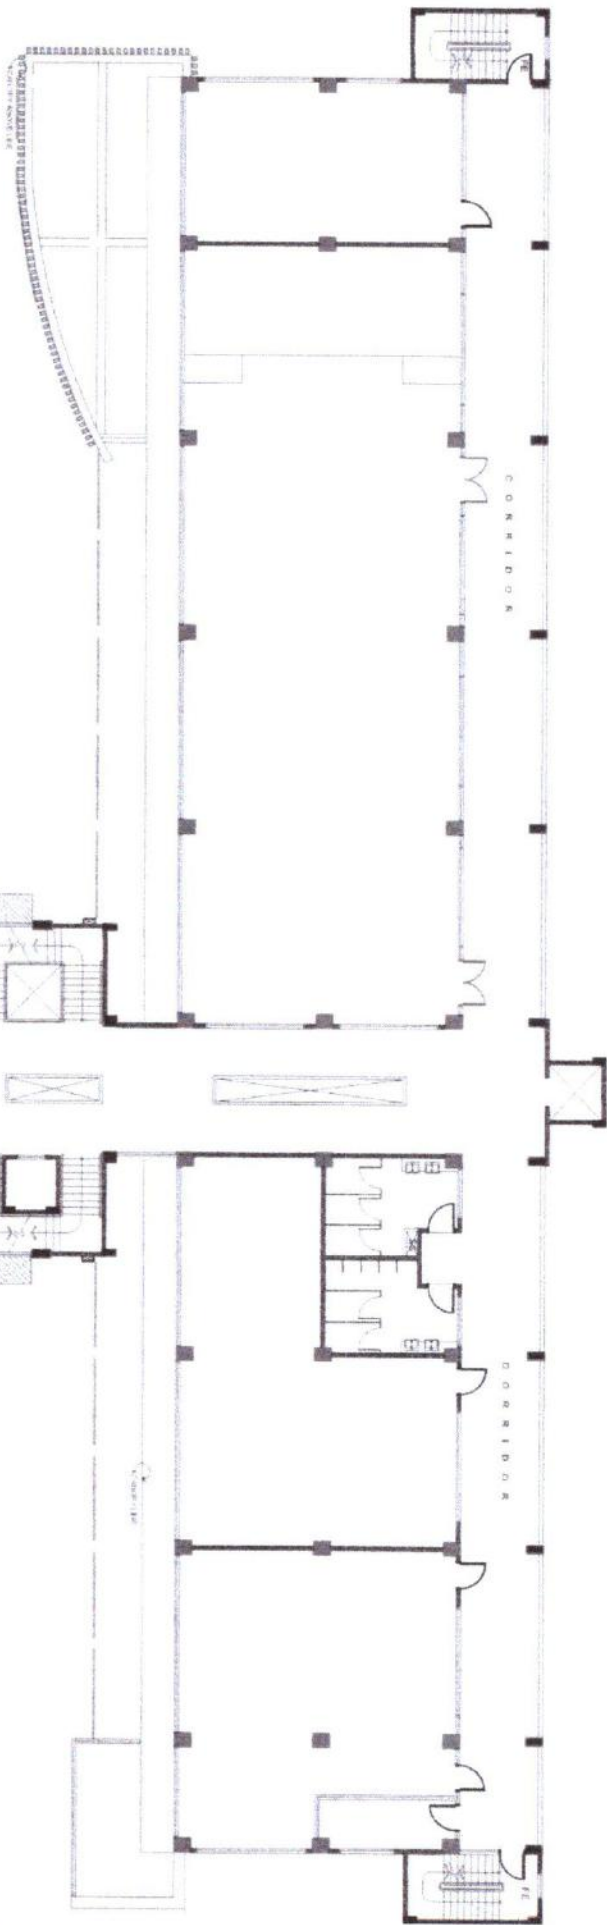

THE SITE (SEE DETAIL)

THE SITE (SEE DETAIL)

**ETG BUILDING GROUND
FLOOR PLAN**
SCALE 1:200M



REPUBLIC OF THE PHILIPPINES
DEPARTMENT OF EDUCATION, CULTURE AND SPORTS
CAGAYAN INLAND MARINA
STATE UNIVERSITY
Region - Cagayan

PROJECT TITLE
CONSTRUCTION OF REPAIR AND ROOFING
AT GROUND FLOOR ETG BUILDING

PREPARED BY:
ARNEL R. LATUBNAS
UNIVERSITY GRADUATE

CHECKED BY:
AS ARCHITECT
ENR. JUAN C. TORIBIO JR.
REGISTERED ARCHITECT

ENR. JERON J. MARGUERA
DIRECTOR PDM

ROSALINDA S. TOVILLA, JD.
VICE PRESIDENT FOR ADMINISTRATION AND FINANCE

APPROVED BY:
NOBERTO P. MANGULABANAN, Ph.D.
RUC PRESIDENT

SHEET NO. A
PAGE NO. 2

SEE CONNECTION DETAIL

LEFT WING

1/8" X 1" G.I. FLAT BAR
SUPPORT FRAME

2" X 2" G.I. TUBULAR STEEL
MAIN ROOF RAFTER

1/8" X 1" G.I. FLAT BAR
SUPPORT FRAME

2" X 2" G.I. TUBULAR STEEL
MAIN ROOF RAFTER



ROOF FRAMING PLAN

SCALE 1:30M



Department of Architecture
**CARLOS HILADO MEMORIAL
 STATE UNIVERSITY**
 Negros Occidental

OFFICE OF THE ARCHITECT, PLANNING
 AND ADMINISTRATION

PROJECT TITLE

CONSTRUCTION OF FISHING ROOFING
 AT GROUND FLOOR BIG BUILDING
 PROJECT LOCATION: TALSAY CAMPUS

PREPARED BY:

ARNEL R. LATERNAS
 UNIVERSITY GRADUATE

CHECKED BY:

AR...
 ENGR. GILBERT S. AVILA, D. R.
 REGISTERED ARCHITECT

APPROVED BY:

ENGR. JIM J. M. COLE
 DIRECTOR PPA

APPROVED BY:

ROSALINDA S. TUYAN, JD
 VICE PRESIDENT FOR ADMINISTRATION AND FINANCE

APPROVED BY:

NORBERTO F. MANCUALANAN, Ph.D
 SUP. RESIDENT

SHEET NO.:

A


PAGE NO.:

3

LEGEND

- 2" x 2" TUBULAR METAL PLATE
- METAL PLATE
- EXPANSION BOLT

PLAN

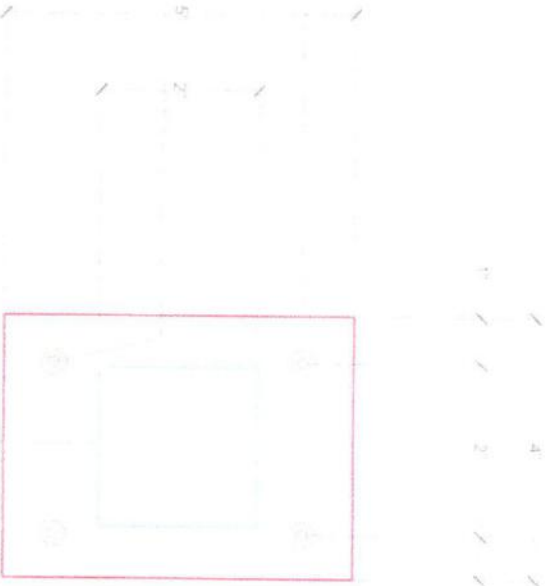

2" x 2" TUBULAR ROOF RAFTER

1/2" THK 0.20m x 0.25m METAL PLATE


12mm Ø EXPANSION BOLT w/ NUT AND WASHER

12mm Ø EXPANSION BOLT w/ NUT AND WASHER

1/2" THK 0.20m x 0.25m METAL PLATE

2" x 2" TUBULAR ROOF RAFTER

SECTION

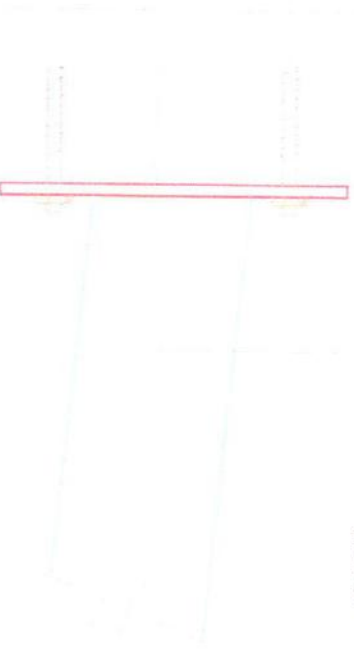

RAFTER CONNECTION TO WALL DETAILS

SCALE

NOTES



STATE OF FLORIDA
PROFESSIONAL ENGINEER
REGISTERED PROFESSIONAL ENGINEER
EXPIRES 12/31/2024

PROJECT TITLE
CONSTRUCTION OF FISHPOND ROOFING AT GROUND FLOOR EFG BUILDING

DESIGNED BY
ARNEIL R. LATUBNAS

CHECKED BY
[Signature]

DESIGNED BY
[Signature]

RECALCULATED BY
[Signature]

APPROVED BY
[Signature]

SHEET NO. **A**
PAGE NO. **5**